

City of Beaumont 5600 - 49 Street Beaumont, Alberta T4X 1A1

Phone: (780) 929-8782 Fax: (780) 929-3300

Email: development@beaumont.ab.ca

Development Permit Notice of Decision

Date of Decision: May 16, 2022

City of Beaumont – Beaumont Fire Services 5600 49 Street

Beaumont, AB. T4X 1A1

Proposed Development: Temporary Government Development: Fire Training Facility

Legal Description: Plan 072 7682, Block 1, Lot 4 **Municipal Address:** 24130 TWP RD 510, Beaumont, AB

Land Use District: Agricultural Holding District

Permit Number: 2021-711 **Tax Roll:** 050500

Development Permit Status: Approved with conditions

Development Permit Conditions

The development noted above is considered a Permitted Use within the Agricultural Holding District, and has been **approved** by the Development Authority subject to the conditions listed below. Unless otherwise provided for in this approval, all requirements of the City of Beaumont Land Use Bylaw 944-19 shall be met. Be sure to review all the documentation included with this permit.

- 1. Development shall commence within one year from the date of decision noted above. If the development does not commence within this time frame, a new development permit will be required.
- 2. Permit shall be valid for 3 years unless an extension has been requested and approved by the Development Authority.
- 3. Shall not include training for "rescue and extraction" response as described within the City of Beaumont's Fire Bylaw 815-13.
- 4. Location of the Fire Training Facility is approved as per the attached site plan.
- 5. Approval is required from Apex Utilities for any work in the southeast corner of the property (Recycling Area) that involves changes to the cover over the Utility line prior to any development. Should there be work in this area, Apex Utility will need to be consulted and written approval granted.
- 6. The Applicant shall ensure that consideration be given to controlling noise on the site in addition to establishing reasonable hours of operation in accordance with Bylaw 642-05 Abatement of Noise.
- 7. Install a windsock and only do burns while the prevailing winds are to the west or northwest and fire shall be directed away from the residential areas.
- 8. Hydrocarbon fuels cannot be used as accelerants.
- 9. Only water shall be used for fire suppression.



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- 12. Only Class "A" material (pallets and plywood sheets) shall be burned onsite as per NFPA 1403 on Live Fire Training,, Fuel Materials 4.13.1.
- 13. Shall comply with City of Beaumont's Fire Bylaw 815-13.
- 14. A separate permit and approval are required for any signage on the building/property which shall follow the regulations of the Land Use Bylaw.

Failure to comply with any of the preceding conditions will render this permit null and void.

Additional Information

- 1. This Notice of Decision is NOT a building permit. Work or construction shall not commence until an applicable Building Permit has been issued under the *Alberta Safety Codes Act* and any other applicable bylaws or regulations.
- 2. This Development Permit is issued under the City of Beaumont Land Use Bylaw 944-19. It does not exempt you from compliance with any other municipal bylaw or statutory plan applicable to the Proposed Development, any relevant federal or provincial statute or regulation, or any easement, covenant, agreement, or contract affecting the subject lands.
- 3. The Fire Training Facility shall be built to the NFPA 1402 Standard for Fire Training Buildings.
- 4. The drawings need to be stamped by an Alberta Engineer.
- 5. Contact Alberta One Call at 1-800-242-3447 to locate underground services prior to construction, if applicable.

Permit Notification Information

In accordance with the City of Beaumont Land Use Bylaw 944-19, notice regarding this Development Permit has been published on our website, only.

For more information regarding this Development Permit, its conditions, or the Land Use Bylaw, contact the Development Authority who made the decision on this permit:



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Shari Edgington Development Officer 780-340-1678

An Tolyington

shari.edgington@beaumont.ab.ca

Appeal Information

Any Development Permit may be appealed to the Subdivision and Development Appeal Board (SDAB) if the permit was:

- a) issued for a permitted use with a variance, or for a discretionary use, or
- b) issued with conditions, or
- c) refused.

An appeal may be filed by:

- a) the person applying for the permit, and/or
- b) any person affected by the issuance of the permit.

As the person applying for the permit, you may appeal the decision of the Development Authority regarding the permit or any conditions placed on the permit (as listed above) within 21 days after the date on which the decision is made.


Notice of Decision: May 16, 2022 **Appeal deadline:** June 6, 2022 **Permit active** (if no appeals filed): June 7, 2022

To file an appeal or to get information on the appeal process you must contact the Secretary of the SDAB directly at 780-929-8782 or at legislative@beaumont.ab.ca. Appeals must be filed no later than 4:30 p.m. on the date indicated above.



May 16, 2022

For location of the Fire Training Facility Only

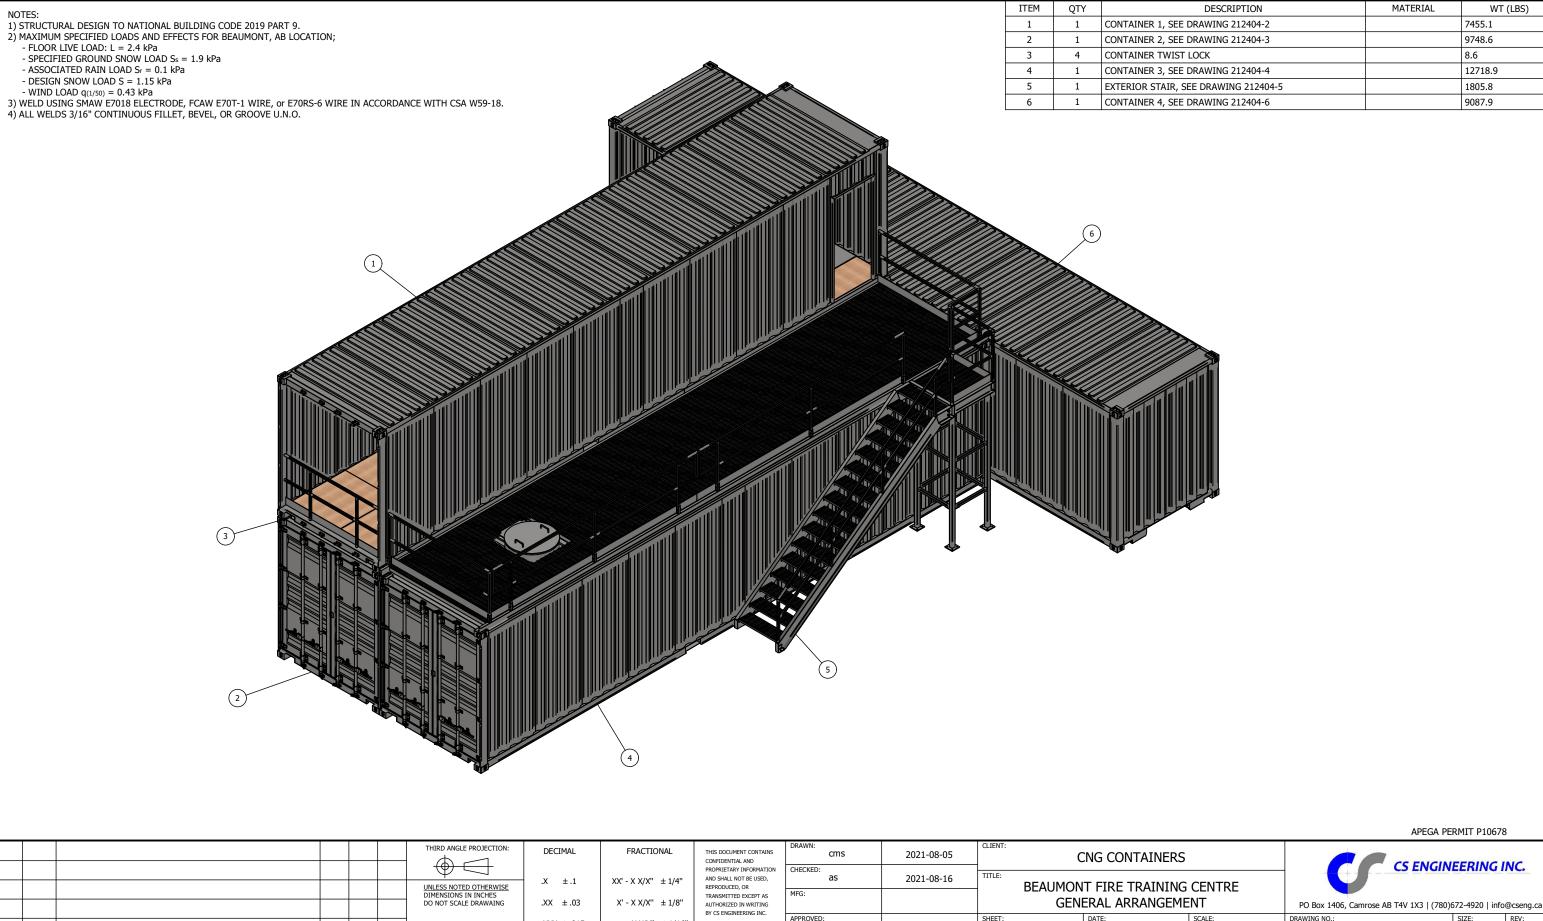

.X ± .1

.XX ± .03

.XXX ± .015

UNLESS NOTED OTHERWISE DIMENSIONS IN INCHES DO NOT SCALE DRAWAING

APP

DRW

CHK


REV DATE DESCRIPTION

XX' - X X/X" ± 1/4"

X' - X X/X" ± 1/8"

X X/X" ± 1/16"

NTAINS	cms	2021-08-05		C	ING CONTAINERS		CS ENGIN	EEDING I	NC			
MATION JSED,	CHECKED: as	2021-08-16	TITLE:	JIMON	T FIRE TRAINING	CENTRE	CS ENGIN	EEKING I	VC.			
PT AS TING INC.	MFG:		DL/		ERAL ARRANGEME		PO Box 1406, Camrose AB T4V 1X3 (780)672-4920 info@cseng.ca					
INC.	APPROVED: CMS	2021-08-16	SHEET: 1 OF	: 3	DATE: 2021-08-05	SCALE: NONE	DRAWING NO.: 212404-1	SIZE: B	REV: 0			

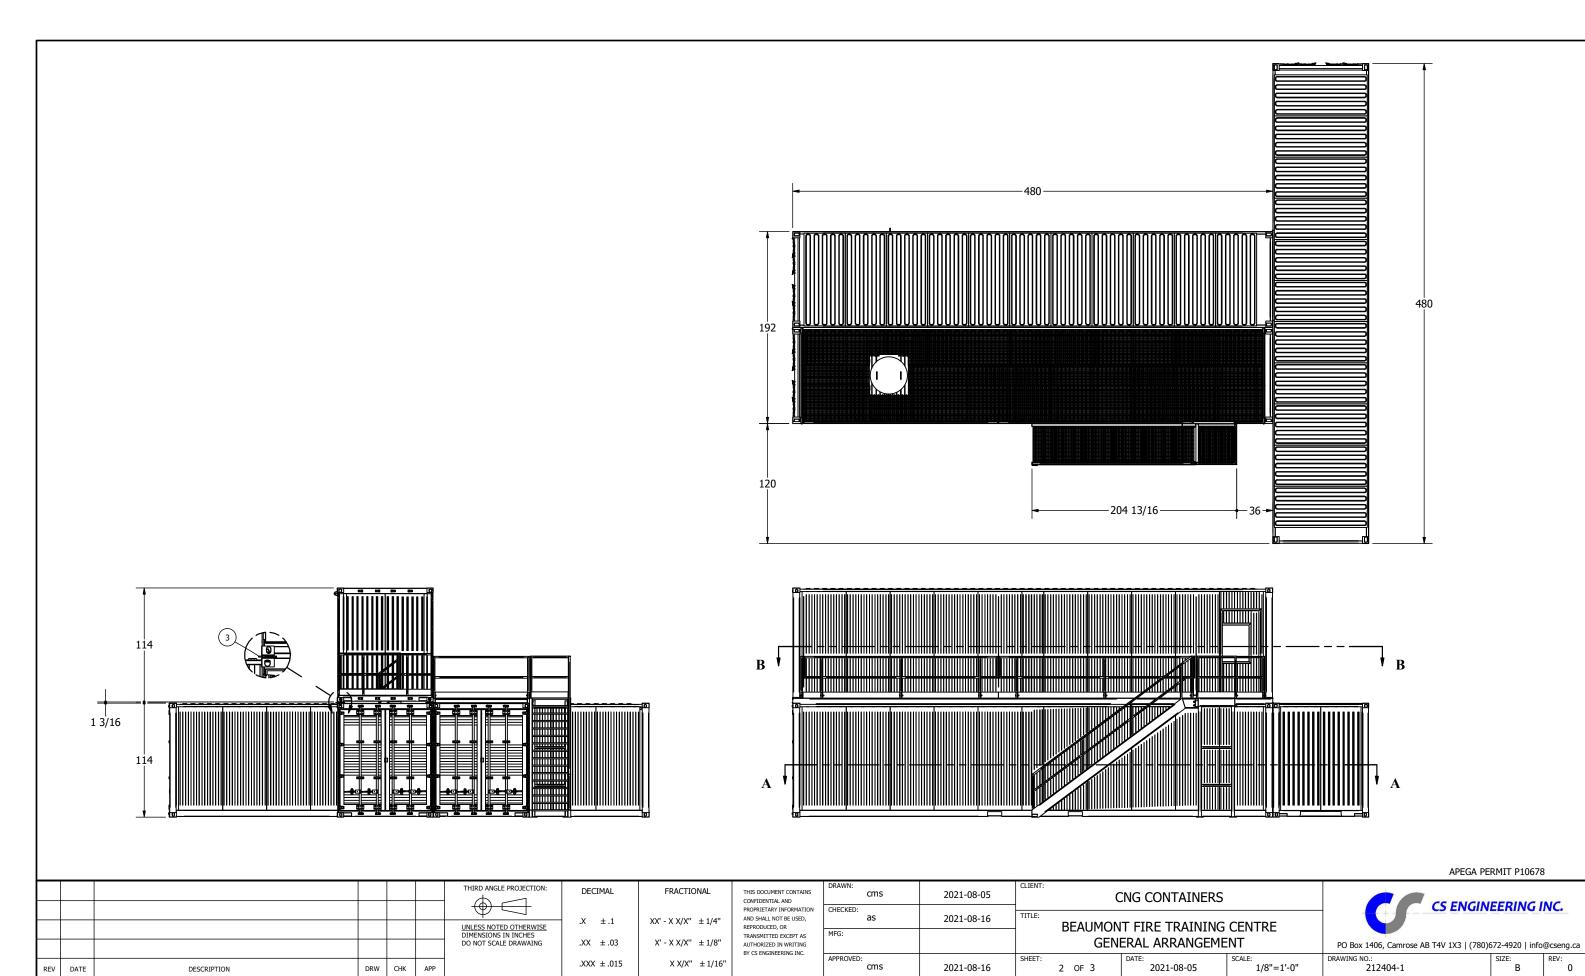

.XXX ± .015

APP

DRW CHK

REV DATE

DESCRIPTION

X X/X" ± 1/16"


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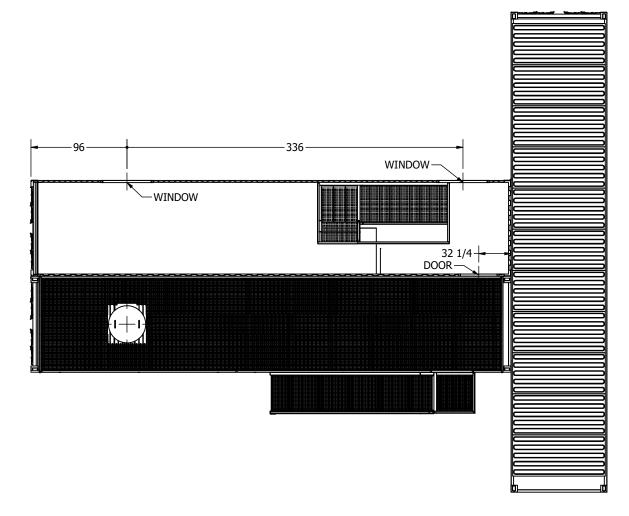
2021-08-16

2021-08-05

2 OF 3

1/8"=1'-0"



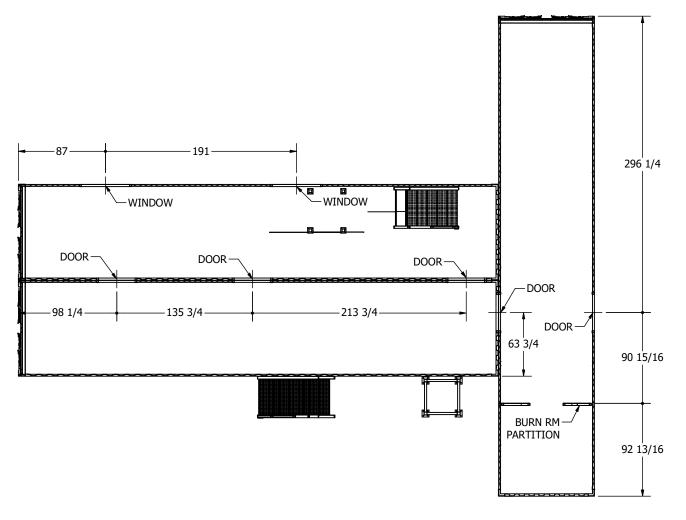

SECTION A-A SECTION B-B


				THIRD ANGLE PROJECTION:	DECIMAL	FRACTIONAL	THIS DOCUMENT CONTAINS CONFIDENTIAL AND	cms 2021-08-05 CNG CONTAINERS		cms 2021-08-05 CNG CONTAINERS		CNG CONTAINERS		S ENGINEERING INC.		
	1			UNLESS NOTED OTHERWISE	.X ± .1	XX' - X X/X" ± 1/4"	AND SHALL NOT RE LISED. AS 2021-08-16 TITLE:		BEAUMONT FIRE TRAINING CENTRE		CS ENGINEERING INC.					
				DIMENSIONS IN INCHES DO NOT SCALE DRAWAING	.XX ± .03	X' - X X/X" ± 1/8"	TRANSMITTED EXCEPT AS AUTHORIZED IN WRITING	MFG:			GENERAL ARRANGEMENT		PO Box 1406, Camrose AB T4V 1X3 (780)672-4920 info@cseng.ca			
REV	DATE	DESCRIPTION	DRW CHK APP		.XXX ± .015	X X/X" ± 1/16"	BY CS ENGINEERING INC.	APPROVED: CMS	2021-08-16	SHEET:	3 OF 3	DATE: 2021-08-05	SCALE: 1/8" = 1'-0"	DRAWING NO.: 212404-1		REV:




- NOTES:


 1) DIMENSIONS MAY VARY PENDING CONTAINER CONSTRUCTION. VERIFY APPLICABLE MATERIAL LENGTHS PRIOR TO FABRICATION.
 2) WELD USING SMAW E7018 ELECTRODE, FCAW E70T-1 WIRE, or E70RS-6 WIRE IN ACCORDANCE WITH CSA W59-18.
 3) ALL WELDS 3/16" CONTINUOUS FILLET, BEVEL, OR GROOVE U.N.O.
 4) DOORS AND WINDOWS PER CONTRACTOR / OWNER REQUIREMENTS.


ITEM	QTY	DESCRIPTION	MATERIAL	WT (LBS)	ITEM	QTY	DESCRIPTION	MATERIAL	WT (LBS)
12	1	1 1/4 x 3/16 BB SERRATED GRATING TO SUIT		438.4	1	1	40 FT HC SHIPPING CONTAINER		8024.9
13	1	1 1/4 x 3/16 BB SERRATED GRATING TO SUIT		84.2	2	4	7' x 3' DOOR FRAME, SEE DRAWING 212404-7		53.1
14	11	2 x 2 x 3/16 HSS, 6 LG., SEE ITEM DETAIL t12	350W	2.1	3	2	C 6 x 8.2, 480 LG.	300W	325
15	1	GUARDRAIL 1, SEE SHEET 5		99.4	4	2	2 x 2 x 3/16 HSS, 90 13/16 LG.	350W	32.7
16	1	GUARDRAIL 2, SEE SHEET 5		49.3	5	2	2 x 2 x 3/16 HSS, 36 LG.	350W	13
17	1	GUARDRAIL 3, SEE SHEET 6		96	6	1	ROOF HATCH, SEE SHEET 4		128.5
18	1	GUARDRAIL 4, SEE SHEET 6		66.8	7	1	HATCH LID, SEE SHEET 4		74.9
19	2	6x1/4 FB, 95 LG.	300W	40.4	8	2	5/8 DIA PIN, SEE ITEM DETAIL r1 SHEET 4	C1018	.2
20	1	6x1/4 FB, 27 5/8 LG.	300W	11.8	9	13	L 3 x 3 x 1/4, 92 1/8 LG.	300W	38
21	1	6x1/4 FB, 194 LG.	300W	82.5	10	1	1 1/4 x 3/16 BB SERRATED GRATING TO SUIT		962.3
22	1	6x1/4 FB, 195 1/4 LG.	300W	83.1	11	1	1 1/4 x 3/16 BB SERRATED GRATING TO SUIT		962.3
23	11	1/2 X 2 3/4 HEX CAPSCREW	SAE GR.5	.2					
24	11	1/2 FLAT WASHER		0]		•		

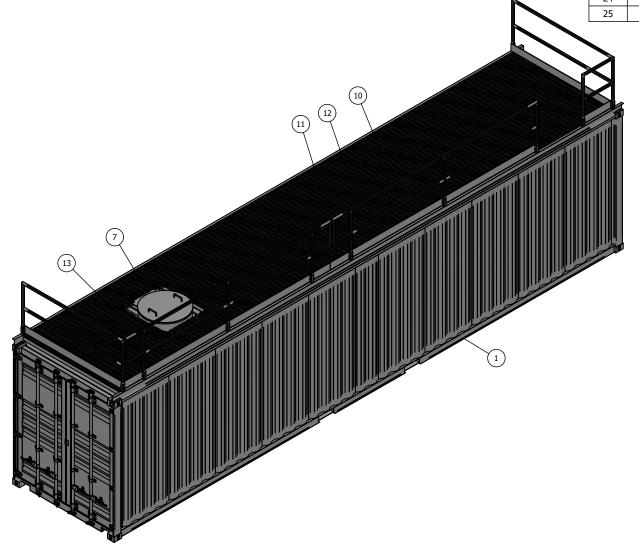


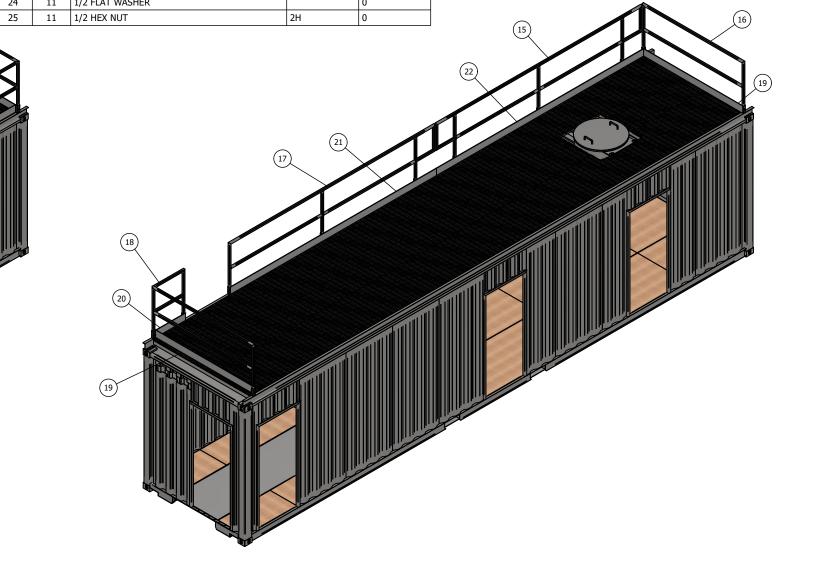


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					UNLESS NOTED OTHERWISE DIMENSIONS IN INCHES	.X ±.1	XX' - X X/X" ± 1/4"	AND SHALL NOT BE USED, REPRODUCED, OR TRANSMITTED EXCEPT AS	MFG:	2021-08-20	TITLE:	BEAUMONT FIRE TRAINING CENTRE		C ZNON	, LL, MI, C		
					DO NOT SCALE DRAWAING	.XX ± .03	X' - X X/X" ± 1/8"	AUTHORIZED IN WRITING BY CS ENGINEERING INC.	APPROVED:		CHEET:	CONTAINER 3 DETAILS HEET: DATE: SCALE:		PO Box 1406, Camrose AB T4V 1X3 (780 DRAWING NO.:)672-4920 in	nfo@cseng.ca	
REV	DATE	DESCRIPTION	DRW	CHK APP		.XXX ± .015	X X/X" ± 1/16"		cms	2021-08-20	SHEET:	1 OF 6	2021-08-05	NONE	212404-4	В	0

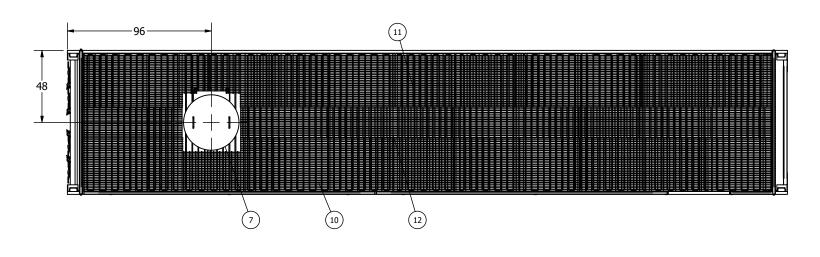

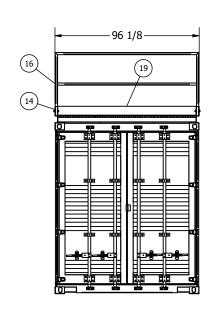


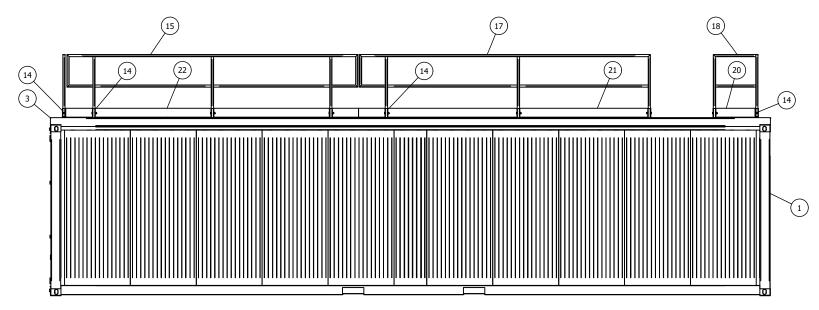


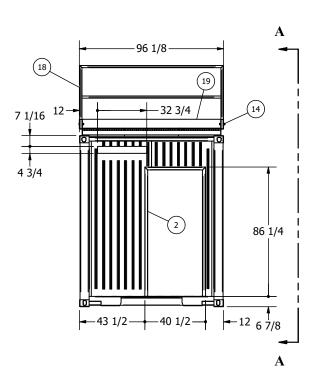


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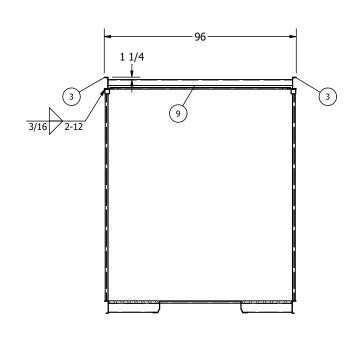
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	DIMENSIONS IN INCHES DO NOT SCALE DRAWAING	.XX ± .03	X' - X X/X" ± 1/8"	TRANSMITTED EXCEPT AS AUTHORIZED IN WRITING	MFG:			BEAUMONT FIRE TRAINING CENTRE CONTAINER 3 DETAILS				PO Box 1406, Camrose AB T4V 1X3 (780)672-4920 info@cseng.ca		
REV	DATE DESCRIPTION DRW CHK APP	.XXX ± .015	X X/X" ± 1/16"	BY CS ENGINEERING INC.	APPROVED: CMS	2021-08-20	SHEET: 2 OF 6	DATE: 2021-08-05	SCALE: 3/16"=1'-0"	DRAWING NO.: 212404-4	SIZE: REV:	0		



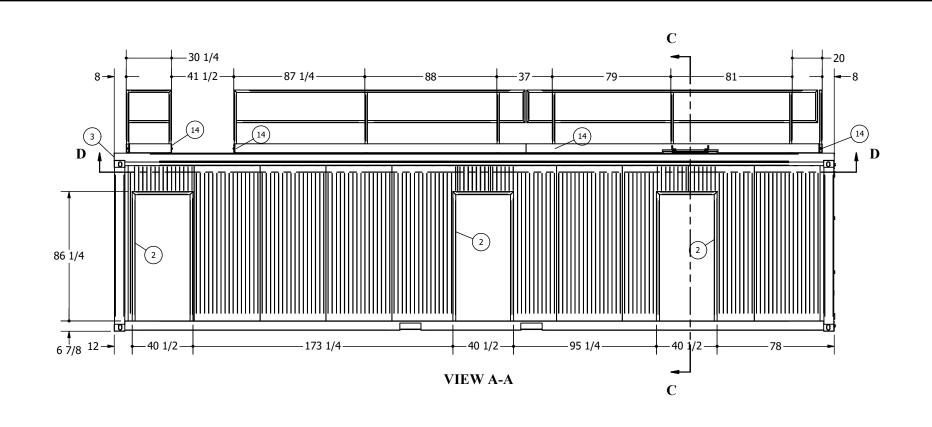

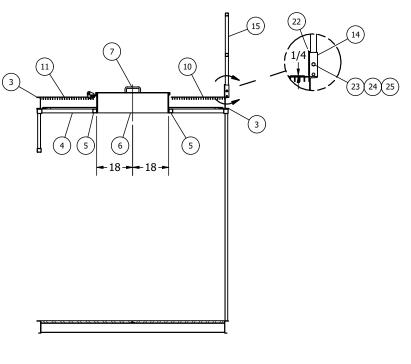
SECTION C-C




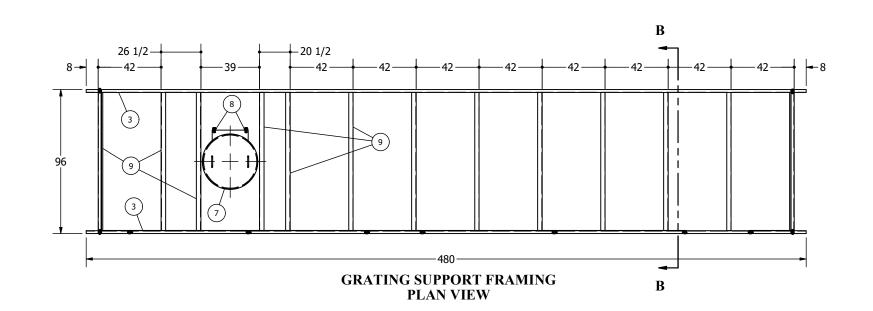



SECTION B-B

				THIRD ANGLE PROJECTION:	DECIMAL	FRACTIONAL	THIS DOCUMENT CONTAINS CONFIDENTIAL AND	cms	2021-08-05	CLIENT:	(CNG CONTAINERS		CNG CONTAINERS CS ENGL		CINICEDIAL	CINC
				UNLESS NOTED OTHERWISE	.X ±.1	NOT NAMED A ALATE AND SHALL NOT RELIEFD AS 2021-08-20 TITLE:			BEAUMONT FIRE TRAINING CENTRE		- CS EN	CS ENGINEERING INC.					
				DIMENSIONS IN INCHES DO NOT SCALE DRAWAING	.XX ± .03	X' - X X/X" ± 1/8"	TRANSMITTED EXCEPT AS AUTHORIZED IN WRITING	MFG:			CONTAINER 3 DETAILS			PO Box 1406, Camrose AB T4V 1X3 (780)672-4920 info@cseng.ca			
REV	DAT	TE DESCRIPTION	DRW CHK APP		.XXX ± .015	X X/X" ± 1/16"	BY CS ENGINEERING INC.	APPROVED: CMS	2021-08-20	SHEET:	3 OF 6	DATE: 2021-08-05	SCALE: NONE	DRAWING NO.: 212404-4	SIZE:	REV:	

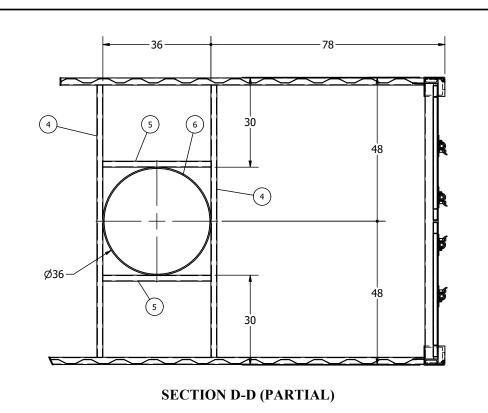

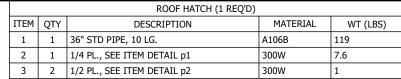

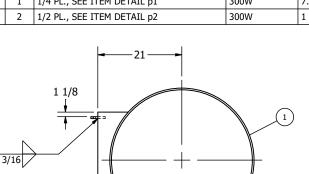


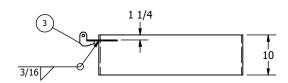


ROOF HATCH

ONE (1) REQ'D

HATCH LID (1 REQ'D) ITEM QTY DESCRIPTION MATERIAL WT (LBS) 1 1 3/16 PL, 37 DIA 300W 57.2 2 1 1 x 3/16 FB, 37 O.D. 300W 6.1 3 2 3/4 RB, SEE ITEM DETAIL r2 C1018 1.4 4 1 1/4 PL., SEE ITEM DETAIL p3 300W 6.6 5 4 1/2 PL., SEE ITEM DETAIL p4 300W

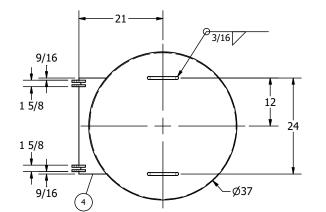

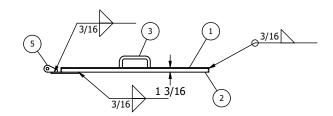


HATCH LID ONE (1) REQ'D

3/16 - 2 - 3/16 - 3/16 - 0/1/8 - CH.1/16

SECTION D-D

2 -- 3/16 Ø1/8 —CH.1/16

ITEM DETAIL r2 TWO (2) REQ'D, 3/4 RB

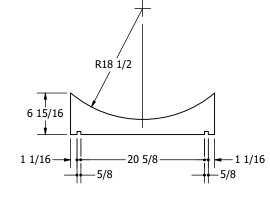

ITEM DETAIL p3 ONE (1) REQ'D, 1/4 PL.

R7/8—	_	
-(5	\bigoplus	<u> </u>
Ø11/16	+	F/9
	 2 1/2	5/8


ITEM DETAIL p4 FOUR (4) REQ'D, 1/2 PL.

7 9/16	R18
	24

ITEM DETAIL r1

TWO (2) REQ'D, C1018 MAT'L

ITEM DETAIL p1 ONE (1) REQ'D, 1/4 PL.

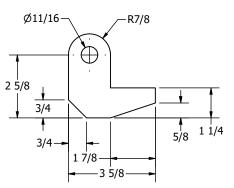

ITEM DETAIL p2 TWO (2) REQ'D, 1/2 PL.

						THIRD ANGLE PROJECTION:
						UNLESS NOTED OTHERWISE DIMENSIONS IN INCHES
						DO NOT SCALE DRAWAING
DEV	DATE	DESCRIPTION	DRW	CHK	ΔΡΡ	

	DECIMAL	FRACTIONAL
_	.X ±.1	XX' - X X/X" ± 1/4
	.XX ± .03	X' - X X/X'' ± 1/8
	.XXX ± .015	X X/X" ± 1/1

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THIS DOCUMENT CONTAINS	
CONFIDENTIAL AND	
PROPRIETARY INFORMATION	C
AND SHALL NOT BE USED,	
REPRODUCED, OR	
TRANSMITTED EXCEPT AS	М
AUTHORIZED IN WRITING	
BY CS ENGINEERING INC.	_
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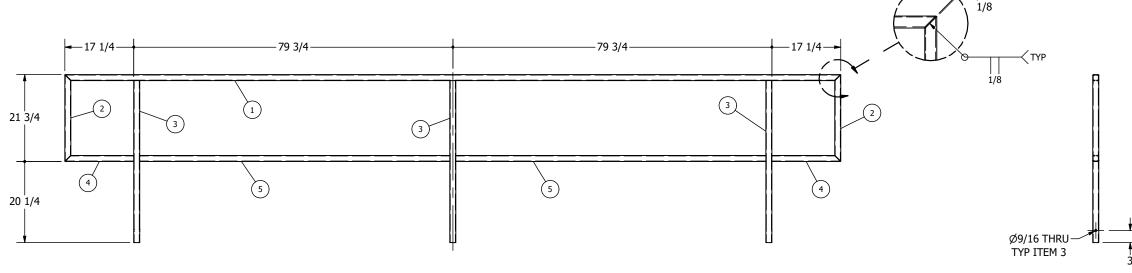
DRAWN: CMS	2021-08-05	CNG CONTAINERS							
CHECKED: as	2021-08-20	BEAUMONT FIRE TRAINING CE							
MFG:		CONTAINER 3 DETAILS							
APPROVED: cms	2021-08-20	SHEET: 4 OF 6	DATE: 2021-08-05	SCALE: NONE					

CS ENG

CS ENGINEERING INC.


APEGA PERMIT P10678

	GUARDRAIL 1 (1 REQ'D)											
ITEM	QTY	DESCRIPTION	MATERIAL	WT (LBS)								
1	1	1 1/2x1 1/2x1/8 HSS, 193 13/16 LG., 45 DEG EA END	350W	35.3								
2	2	(1 1/2x1 1/2x1/8) HSS, 21 9/16 LG., 45 DEG EA END	350W	3.7								
3	3	1 1/2x1 1/2x1/8 HSS, 40 1/2 LG.	350W	7.4								
4	2	1 1/2x1 1/2x1/8 HSS, 17 3/16 LG., 45 DEG ONE END	350W	3								
5	2	1 1/2x1 1/2x1/8 HSS, 77 1/2 LG.	350W	14.2								




GUARDRAIL 1 ONE (1) REQ'D

	GUARDRAIL 2 (1 REQ'D)											
ITEM	QTY	DESCRIPTION	MATERIAL	WT (LBS)								
1	1	1 1/2x1 1/2x1/8 HSS, 95 7/16 LG., 45 DEG EA END	350W	17.2								
2	2	(1 1/2x1 1/2x1/8) HSS, 41 15/16 LG., 45 DEG ONE END	350W	7.5								
3	1	1 1/2x1 1/2x1/8 HSS, 92 5/8 LG.	350W	17								

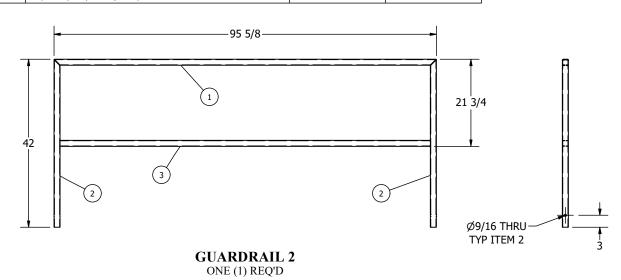


					THIRD ANGLE PROJECTION:	DECIMAL	FRACTIONAL	THIS DOCUMENT CONTAINS CONFIDENTIAL AND	DRAWN: CMS	2021-08-05	CLIENT:	CNG CONTAINERS BEAUMONT FIRE TRAINING CENTRE CONTAINER 3 DETAILS			CS ENGINEERING INC.			
					UNLESS NOTED OTHERWISE DIMENSIONS IN INCHES	.X ± .1	XX' - X X/X" ± 1/4"	PROPRIETARY INFORMATION AND SHALL NOT BE USED, REPRODUCED, OR	CHECKED: as MFG:	2021-08-20	TITLE:				PO Box 1406, Camrose AB T4V 1X3 (780)672-4920 info@cseng.ca			
					DO NOT SCALE DRAWAING	.XX ± .03	X' - X X/X'' ± 1/8"	TRANSMITTED EXCEPT AS AUTHORIZED IN WRITING BY CS ENGINEERING INC.										
REV	DATE	DESCRIPTION	DRW	CHK APP		.XXX ± .015	X X/X" ± 1/16"		APPROVED: CMS	2021-08-20	SHEET:	5 OF 6	DATE: 2021-08-05	SCALE: 1/2" = 1'-0"	DRAWING NO.: 212404-4	SIZE: B	REV: 0	


	GUARDRAIL 3 (1 REQ'D)											
ITEM	QTY	DESCRIPTION	MATERIAL	WT (LBS)								
1	1	1 1/2x1 1/2x1/8 HSS, 85 3/4 LG.	350W	15.7								
2	2	1 1/2x1 1/2x1/8 HSS, 40 1/2 LG.	350W	7.4								
3	1	1 1/2x1 1/2x1/8 HSS, 86 1/2 LG.	350W	15.9								
4	1	1 1/2x1 1/2x1/8 HSS, 17 3/16 LG., 45 DEG ONE END	350W	3								
5	1	1 1/2x1 1/2x1/8 HSS, 21 9/16 LG., 45 DEG EA END	350W	3.7								
6	1	1 1/2x1 1/2x1/8 HSS, 193 13/16 LG., 45 DEG EA END	350W	35.3								
7	1	1 1/2x1 1/2x1/8 HSS, 41 15/16 LG., 45 DEG ONE END	350W	7.5								
17 1/4												

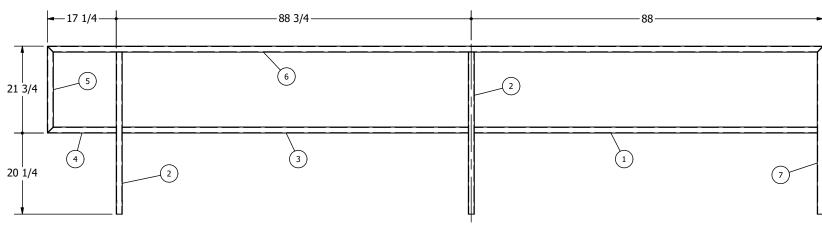

GUARDRAIL 3 ONE (1) REQ'D

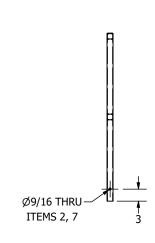

	GUARDRAIL 4 (1 REQ'D)											
ITEM	QTY	MATERIAL	WT (LBS)									
1	3	1 1/2x1 1/2x1/8 HSS, 41 15/16 LG., 45 DEG ONE END	350W	7.5								
2	1	1 1/2x1 1/2x1/8 HSS, 95 7/16 LG., 45 DEG EA END	350W	17.2								
4	1	1 1/2x1 1/2x1/8 HSS, 28 3/16 LG., 45 DEG ONE END	350W	5								
5	1	1 1/2x1 1/2x1/8 HSS, 92 5/8 LG.	350W	17								
6	1	1 1/2x1 1/2x1/8 HSS, 26 3/4 LG.	350W	4.9								

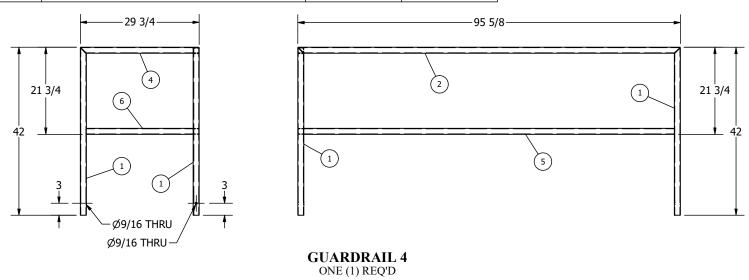

			THIRD ANGLE PROJECTION:	DECIMAL	FRACTIONAL	THIS DOCUMENT CONTAINS CONFIDENTIAL AND	DRAWN: CMS	2021-08-05	CNG CONTAINERS TITLE: BEAUMONT FIRE TRAINING CENTRE CONTAINER 3 DETAILS			CS ENGINEERING INC.			
			UNLESS NOTED OTHERWISE	.X ±.1	XX' - X X/X" ± 1/4"	PROPRIETARY INFORMATION AND SHALL NOT BE USED, REPRODUCED, OR	CHECKED: as	2021-08-20				CS ENGINEERING INC.			
			DIMENSIONS IN INCHES DO NOT SCALE DRAWAING	.XX ± .03	X' - X X/X'' ± 1/8"	TRANSMITTED EXCEPT AS AUTHORIZED IN WRITING BY CS ENGINEERING INC.	MFG:					PO Box 1406, Camrose AB T4V 1X3 (780)	672-4920 info@cseng.ca		
REV	DATE	DESCRIPTION DRW CHK A	P	.XXX ± .015	X X/X" ± 1/16"	BI CS ENGINEERING INC.	APPROVED: CMS	2021-08-20	SHEET: 6 OF 6	DATE: 2021-08-05	SCALE: 1/2" = 1'-0"	DRAWING NO.: 212404-4	SIZE: REV: 0		

